Memorandum to the City of Markham Committee of Adjustment

June 28, 2021

File: A/075/21

Address: 29 Montgomery Court – Markham, ON

Applicant: Eric Ho

Agent: Four Seasons Sunrooms (Nour Elgendy)

Hearing Date: July 7, 2021

The following comments are provided on behalf of the Central Team. The applicant is requesting relief from the following "Fourth Density – Single Family Residential (R4)" zone requirements under By-law 221-81, as amended, as it relates to a proposed rear sunroom addition. The requested variance is to permit:

a) By-law 221-81, Sec. 6.1.2 c):

a maximum lot coverage of 34.80%, whereas the by-law permits a maximum lot coverage of 33.33%.

BACKGROUND

Property Description

The 617.25 m² (6,644.07 ft²) subject property is located on the east side of Montgomery Court, north of Highway 7 East, south of Apple Creek Boulevard, and west of Woodbine Avenue. The property is located within a residential neighbourhood which contains a mix of one and two-storey detached dwellings.

Proposal

The applicant is proposing to construct a one-storey 28.38 m² (305.53 ft²) sunroom addition to the rear of the existing detached dwelling.

Official Plan and Zoning

Official Plan 2014 (partially approved on Nov 24/17, and further updated on April 9/18) The subject property is designated "Residential Low Rise", which provides for low rise housing forms including single detached dwellings.

Zoning By-Law 221-81

The subject property is zoned "Fourth Density – Single Family Residential (R4)" under Bylaw 221-81, as amended, which permits one single detached dwelling per lot. The proposed development exceeds the maximum lot coverage requirement.

Zoning Preliminary Review (ZPR) Not Undertaken

The applicant has confirmed that a ZPR has not been conducted. However, the applicant has received comments from the building department through their permit process to confirm the variances required for the proposed development.

COMMENTS

The *Planning Act, R.S.O. 1990, c. P.13, as amended,* states that four tests must be met in order for a variance to be granted by the Committee of Adjustment ("the Committee"):

a) The variance must be minor in nature;

- b) The variance must be desirable, in the opinion of the Committee, for the appropriate development or use of land, building or structure;
- c) The general intent and purpose of the Zoning By-law must be maintained;
- d) The general intent and purpose of the Official Plan must be maintained.

Increase in Maximum Lot Coverage

The applicant is requesting a maximum lot coverage of 34.80%, whereas the By-law permits a maximum lot coverage of 33.33%. Approval of the requested variance would facilitate the construction of a one-storey sunroom addition to the east wall (rear) of the existing detached dwelling, with a gross floor area of approximately 28.38 m² (305.53 ft²).

Staff are of the opinion that the requested variance is minor in nature and that the proposed development will not significantly add to the scale and mass of the dwelling. In the event of approval, staff recommend that the conditions detailed in Appendix "A" be adopted.

PUBLIC INPUT SUMMARY

No written submissions were received as of June 28, 2021. It is noted that additional information may be received after the writing of the report, and the Secretary-Treasurer will provide information on this at the meeting.

CONCLUSION

Planning staff have reviewed the application with respect to Section 45(1) of the *Planning Act*, and are of the opinion that the variance request meets the four tests, and have no objections. Staff recommend that the Committee consider public input in reaching a decision.

The onus is ultimately on the applicant to demonstrate why they should be granted relief from the requirements of the zoning by-law, and how they satisfy the tests of the *Planning Act* required for the granting of minor variances.

APPENDICES

Appendix "A" – Conditions of Approval Appendix "B" – Plans

PREPARED BY:

Aleks Todorovski, Planner, Zoning and Special Projects

REVIEWED BY:

Sabrina Bordone, Senior Planner, Central District


APPENDIX "A" CONDITIONS TO BE ATTACHED TO ANY APPROVAL OF FILE A/075/21


- 1. The variance applies only to the proposed development as long as it remains.
- 2. That the variance applies only to the proposed development, in substantial conformity with the batch stamped plans attached as Appendix "B" to this Staff Report, and that the Secretary-Treasurer receive written confirmation from the Director of Planning and Urban Design or designate that this condition has been fulfilled to his or her satisfaction.

CONDITIONS PREPARED BY:

Aleks Todorovski, Planner, Zoning and Special Projects

APPENDIX "B" PLANS TO BE ATTACHED TO ANY APPROVAL OF FILE A/075/21

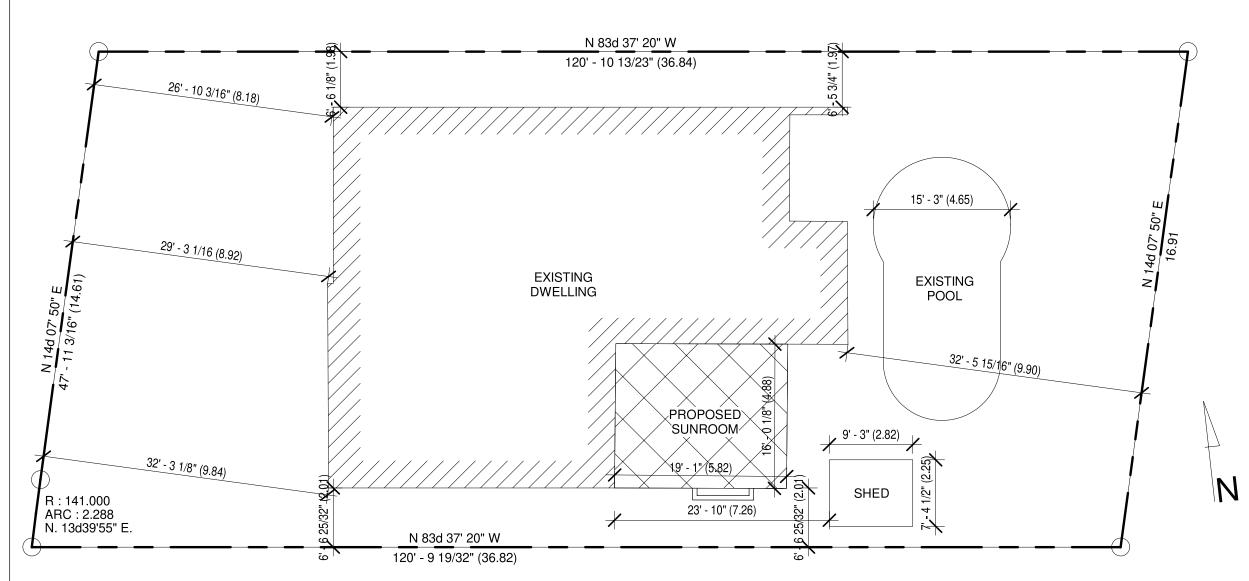

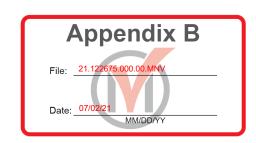

Site Plan
3/32" = 1'-0"

SITE STATISTICS

LOT AREA = 6,644.07 SF (617.25 SM)

EXISTING HOUSE = 1,936.29 SF (179.88 SM)

EXISTING SHED = 68.22 SF (6.34 SM)

ADDITION = 305.53 SF (28.38 SM)

LOT COVERAGE

(HOUSE/SHED/ADDITION) = 34.75% LOT COVERAGE (HOUSE) = 29.14 % LOT COVERAGE (SHED =) 1.02 % LOT COVERAGE (ADDITION =) 4.59 % The undersigned has reviewed and takes responsibility for this design, and has the qualifications and meets the requirements set out in the Ontario Building Code to design the work shown on the attached documents.

NAME

SIGNATURE

Alexandra Aodesh

101509


BCIN



Kathleen Chen & Eric Ho.

No.	Description	Date

Site Plan				
Project number	Project Number			
Date	Issue Date	A102		
Drawn by	Author	, , , , , ,		
Checked by	Checker	Scale 3/32" = 1'-0"		

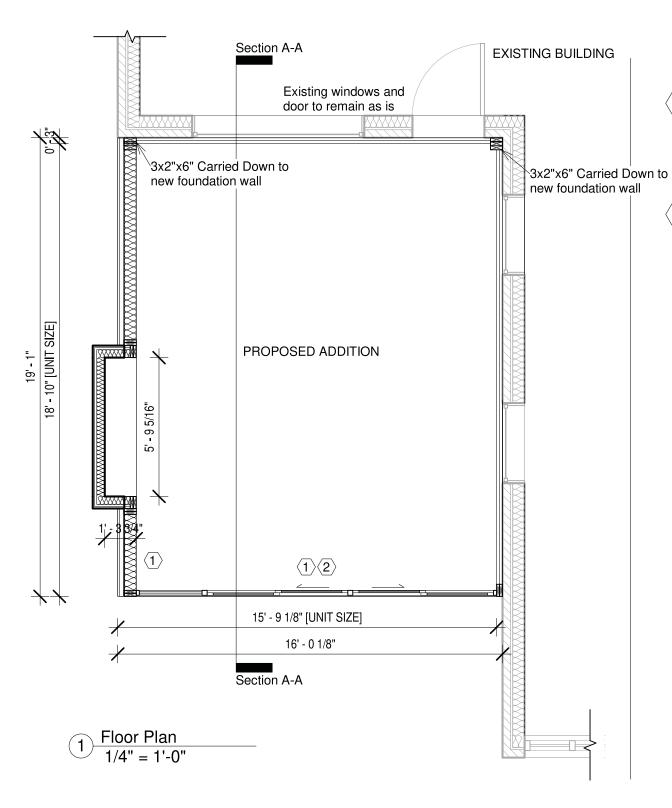

NOTES

BASEWALL/ SOLID WALLS
WALL STUDS TO BE 2x6 ON 16" CENTERS
R22 BATT INSULATION w. R10ci w. 6 MIL VAPOUR BARRIER
1/2" DRYWALL TAPED, SANDED, PRIMED WHITE READY FOR PAINT
1/2" PLYWOOD EXTERIOR SHEATHING WITH TYVEK BUILDING PAPER
ARCHITECTURAL ALUMINUM SIDING EXTERIOR

VERTICAL GLAZING
DOORS & WINDOWS- RESISTANCE TO FORCED ENTRY AND AS
TO O.B.C. DIV. B, 9.7.2. & 9.7.3. * 9.7.4. & 9.7.6.
7E HIGH PERFORMANCE GLAZING
TO BE CONSERVAGLASS (MC-7E)
MULTI-COAT GLAZING TECHNOLOGY (CODE 7E)
EASY-CLEAN II EXTERIOR COATING + STAY-CLEAN TECHNOLOGY
ARGON GAS FILLED FOR BETTER INSULATION
75% REDUCTION IN TOTAL SOLAR TRANSMITTANCE
HIGH VISIBLE TRANSMITTANCE
R 4.0/ U 0.25 CENTER OF GLASS INSULATION VALUE
STAINLESS STEEL CONTINUOUS BENT SPACERS
DUAL POLY- ISOBUTYLENE AND SILICONE SEALS
FULLY TEMPERED INSULATED SAFETY GLASS
PROTECTIVE GLASS MASKING



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NAME

SIGNATURE

TURE BCIN

Alexandra Aodesh


101509



Kathleen Chen & Eric Ho.

No.	Description	Date

Ground Floor Plan			
Project number	Project Number		
ate	Issue Date	A104	
rawn by	Author		
Checked by	Checker	Scale 1/4" = 1'-0"	

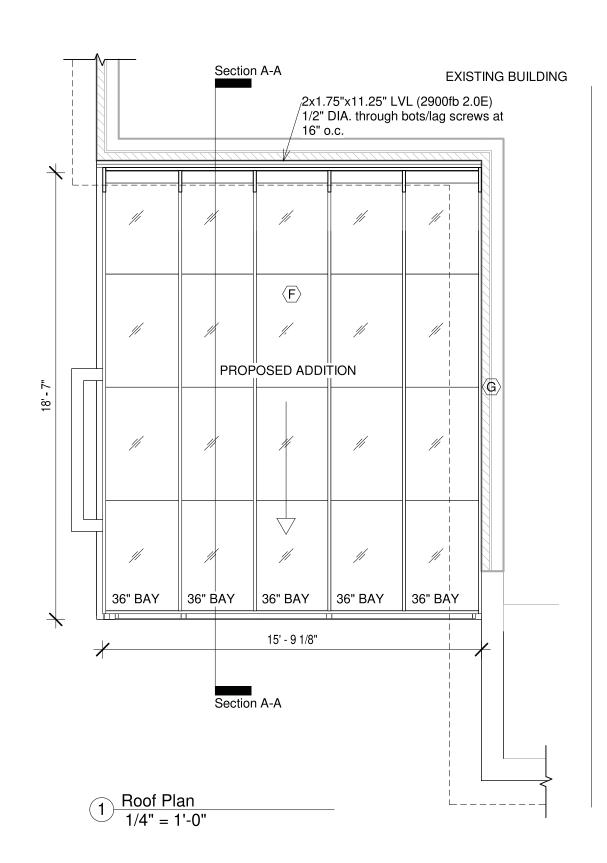

NOTES

F ROOF GLAZING
CODE 78 HIGH PERFORMANCE GLAZING
TO BE CONSERVAGLASS (MC-16)
EASY-CLEAN II EXTERIOR COATING + STAY-CLEAN TECHNOLOGY
ARGON GAS FILLED FOR BETTER INSULATION
90% REDUCTION IN TOTAL SOLAR TRANSMITTANCE
HIGH VISIBLE TRANSMITTANCE
R 4.0/ U 0.25 CENTER OF GLASS INSULATION VALUE
STAINLESS STEEL CONTINUOUS BENT SPACERS
DUAL POLY-ISOBUTYLENE AND SILICONE SEALS
FULLY TEMPERED INSULATED SAFETY GLASS
PROTECTIVE GLASS MASKING

G FLASHING
ALUM. FLASHINGS @ SILICONE SEALANT AT RIDGE MIN. 0.48mm
THICK ALUM.
COATED FLASHING SEAL AT SUNROOM RIDGE

<u>DESIGN LOADS</u> SNOW LOADS: 1.12kPa WIND LOADS: 0.44kPa



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NAME

SIGNATURE

Alexandra Aodesh

101509


BCIN



Kathleen Chen & Eric Ho.

No.	Description	Date

Roof Plan		
Project number	Project Number	
Date	Issue Date	A105
Drawn by	Author	
Checked by	Checker	Scale 1/4" = 1'-0"

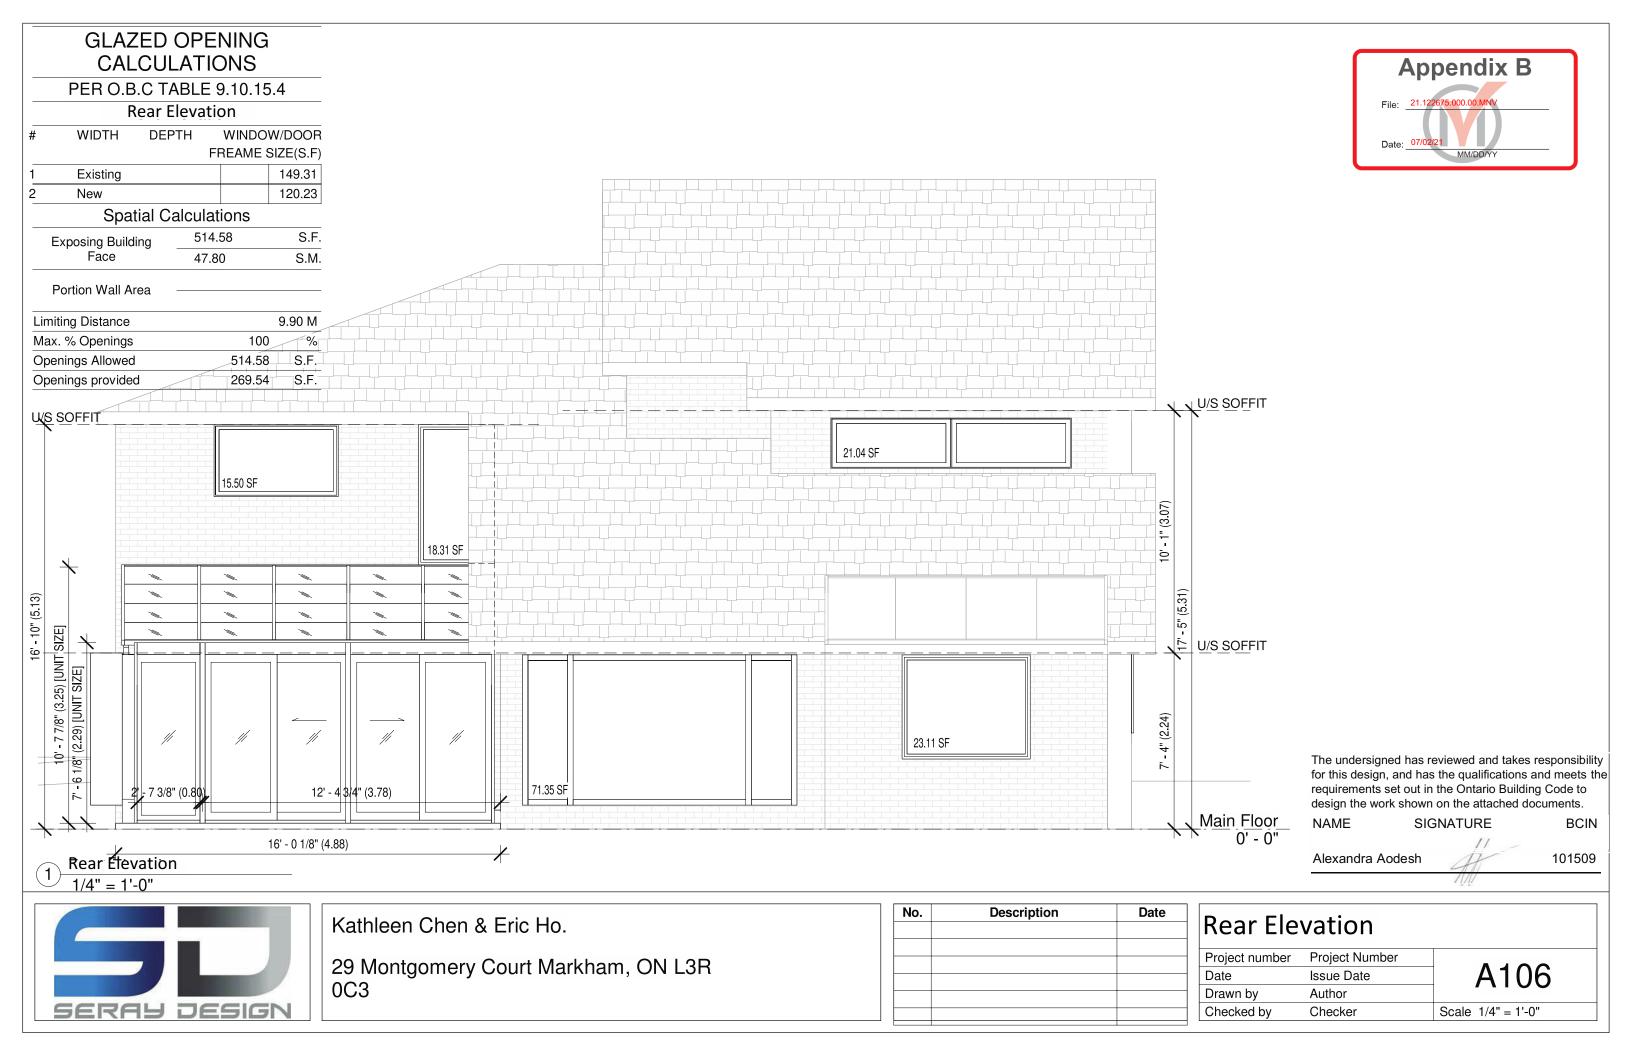



PER O.B.C TABLE 9.10.15.4

Right Elevation

#	WIDTH	DEPTH	WINDO	W/DOOR
			FREAME	SIZE(S.F)
1	Existing			n/a
2	New			35.28

Spatial Calculations

Exposing Building	916.55	S.F
Face	85.15	S.M

Portion Wall Area

U/S SOFFIT

Limiting Distance		2.0
Max. % Openings	09	(
Openings Allowed	82.49	S.I
Openings provided	35.28	S.I



1'.0"
2"
Wis soffin

Main Floor
6' - 0"

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NAME

SIGNATURE

RE BCIN

Alexandra Aodesh

101509



1 Right Elevation 3/16" = 1'-0"

Kathleen Chen & Eric Ho.

No.	Description	Date

Right Elevation			
Project number	Project Number		
Date	Issue Date	A107	
Drawn by	Author	7 (10)	
Checked by	Checker	Scale 3/16" = 1'-0"	