# **Memorandum to the City of Markham Committee of Adjustment** March 22, 2024

File: A/206/23

Address: 125 Commerce Valley Drive West, Markham Applicant: TECHNOARCH INC (HARPREET BHONS)

Hearing Date: Wednesday, April 3, 2024

The following comments are provided on behalf of the West Team:

The applicant is requesting relief from the following requirements of the Select Industrial Limited Commercial (M.C. (76%)) zone under By-law 165-80, as amended, to permit:

## a) By-law 165-80, Section 6.4.1(c)(i):

a restaurant as an accessory use within an existing office building; whereas, the By-law does not permit restaurants within an office building;

as it relates to a proposed restaurant in an existing office building.

## **BACKGROUND**

# **Property Description**

The approximately 1.75 ha (4.32 ac) subject property is located on the west side of Commerce Valley Drive West, south of Highway 7 and west of Leslie Street. The property is currently occupied by an 8-storey office building.

## **Proposal**

The applicant is requesting relief from the By-law to permit a 492 m<sup>2</sup> (5,296 ft<sup>2</sup>) restaurant on the ground floor of the existing office building. The main entrance to the restaurant will be integrated within the existing office building.

## Official Plan and Zoning

Official Plan 2014 (partially approved on November 24/17, and updated on April 9/18) The subject property is designated 'Business Park Office Priority Employment' in the 2014 Official Plan. This designation provides for a restaurant as an ancillary use provided it does not exceed the total gross floor area of the ground floor of the existing office building and that the access to the ancillary use is integrated within the building. The proposed restaurant meets both requirements. Staff recommend that any approval of the application include the conditions attached in Appendix A.

# Zoning By-Law 165-80

The subject property is zoned Select Industrial Limited Commercial (M.C. (76%)) under By-law 165-80, as amended. The M.C. (76%) Zone permits industrial uses, banks and financial institutions, business offices, commercial schools, and hotels and motels. The By-law does not permit the proposed restaurant use.

# **Zoning Preliminary Review (ZPR) Not Undertaken**

The owner has confirmed that a Zoning Preliminary Review (ZPR) has <u>not</u> been conducted. It is the owner's responsibility to ensure that the application has accurately identified all the variances to the Zoning By-law required for the proposed development. If the variance request in this application contains errors, or if the need for additional variances is identified during the Building Permit review process, further variance application(s) may be required to address the non-compliance.

### **COMMENTS**

The Planning Act states that four tests must be met in order for a variance to be granted by the Committee of Adjustment:

- a) The variance must be minor in nature;
- b) The variance must be desirable, in the opinion of the Committee of Adjustment, for the appropriate development or use of land, building or structure;
- c) The general intent and purpose of the Zoning By-law must be maintained;
- d) The general intent and purpose of the Official Plan must be maintained.

## **Restaurant Use**

The proposed 492 m² (5,296 ft²) restaurant will be located entirely on the ground floor of the existing office building. In addition, the entrance to the restaurant is integrated within the office building. Staff are of the opinion that the requested variance is minor in nature as the proposed restaurant meets the requirements set out in the Official Plan for ancillary restaurant uses, and therefore, have no objections.

# Toronto and Region Conservation Authority (TRCA)

The subject lands are located within the regulated area of the TRCA. However, given that no changes are being proposed to the exterior of the building, the TRCA have no concerns with the application.

## **PUBLIC INPUT SUMMARY**

No written submissions were received as of March 22, 2024. It is noted that additional information may be received after the writing of the report, and the Secretary-Treasurer will provide information on this at the meeting.

# **CONCLUSION**

Planning Staff have reviewed the application with respect to Section 45(1) of The Planning Act, R.S.O. 1990, c. P.13, as amended, and are of the opinion that the variance request meets the four tests of the Planning Act and have no objection. Staff recommend that the Committee consider public input in reaching a decision.

The onus is ultimately on the applicant to demonstrate why they should be granted relief from the requirements of the zoning by-law, and how they satisfy the tests of the Planning Act required for the granting of minor variances.

Please refer to Appendix "A" for conditions to be attached to any approval of this application.

PREPARED BY:

Houley Mills

Hailey Miller, Planner II, West District

**REVIEWED BY:** 

Rick Cefaratti, MCIP, RPP, Senior Planner, West District

File Path: Amanda\File\ 23 148511 \Documents\District Team Comments Memo

# APPENDIX "A" CONDITIONS TO BE ATTACHED TO ANY APPROVAL OF FILE A/206/23

- 1. The variances apply only to the proposed development as long as it remains;
- 2. That the variances apply only to the subject development, in substantial conformity with the plan(s) attached as 'Appendix B' to this Staff Report, and that the Secretary-Treasurer receive written confirmation from the Supervisor of the Committee of Adjustment or designate that this condition has been fulfilled to their satisfaction;
- 3. The restaurant only be located on the ground floor of the building;
- 4. Primary access to the restaurant shall be integrated within the building.


CONDITIONS PREPARED BY:

Wast District.


Hailey Miller, Planner II, West District


# LIST OF ARCHITECTURAL DRAWINGS

SHEET NO.	DRAWING TITLE
A00	COVERSHEET + LIST OF DRAWINGS + KEY PLAN
A01	OBC MATRIX + GENERAL NOTES
A02	SITE PLAN
A03	EXISTING FLOOR PLAN
A04	PROPOSED LAYOUT PLAN

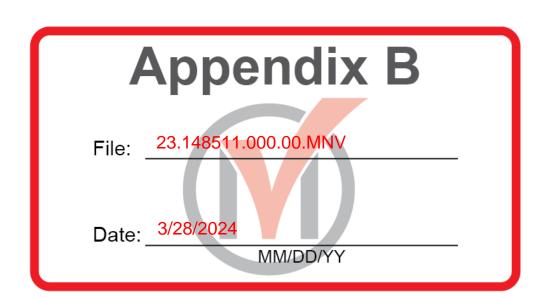

PROPOSED MEHFILL RESTAURANT AND BAR
UNIT 50 & 51 -125 COMMERCE VALLEY DRIVE WEST
MARKHAM, ON

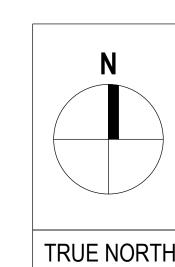

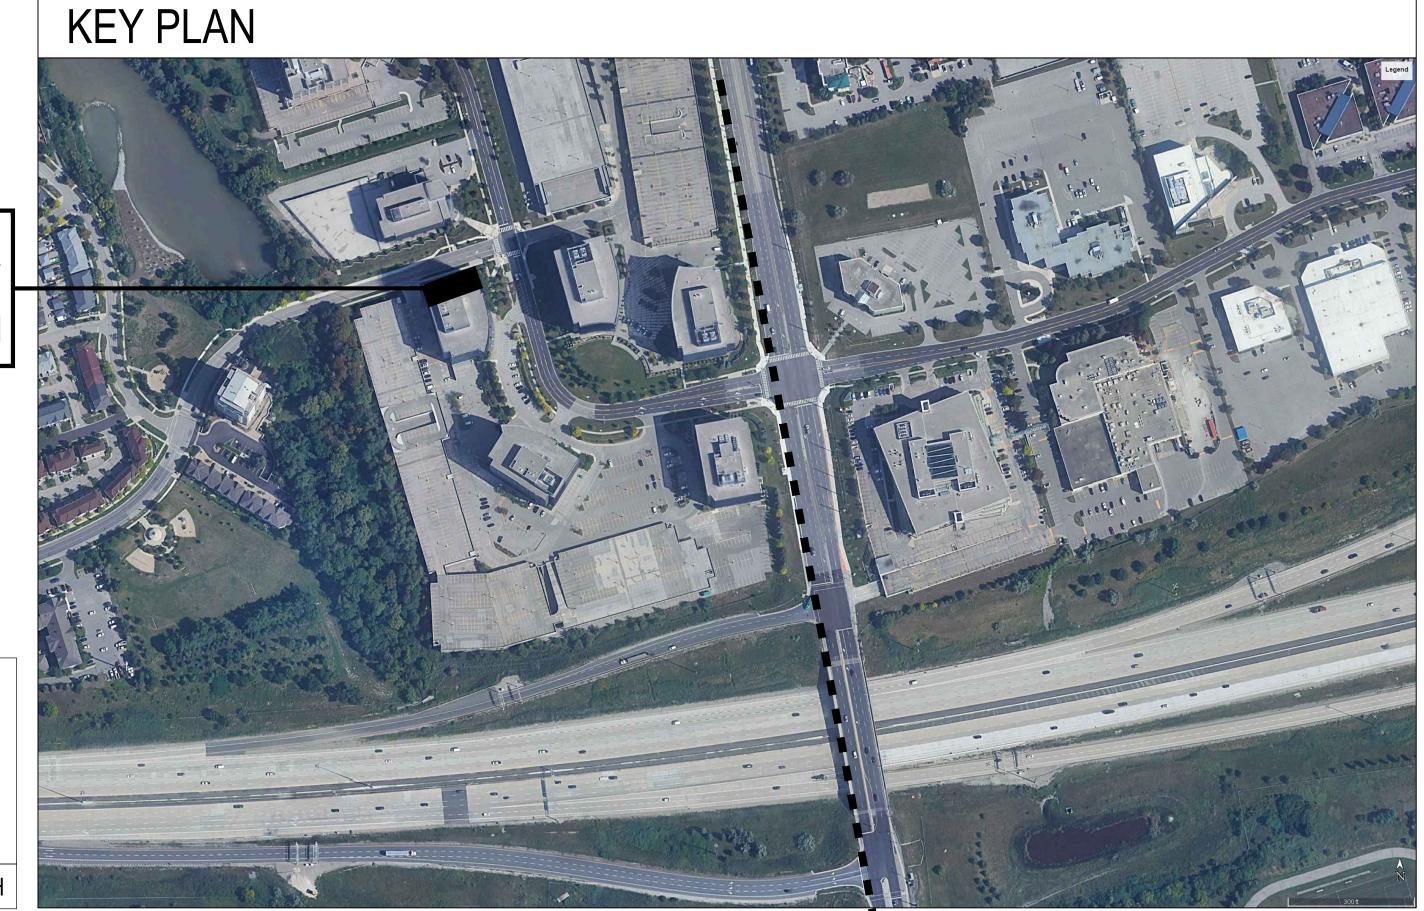

AT UNIT 50 & 51- 125 COMMERCE VALLEY DRIVE WEST, MARKHAM, ON



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# Appendix B

MM/DD/YY

OBC REFERENCE

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VARIANCE

23.148511.000.00.MN\

# NOTE:

CONTRACTOR TO CAREFULLY READ THESE NOTES AND FOLLOW DURING CONSTRUCTION. CHANGES/SUBSTITUTION WILL NOT BE ACCEPTABLE WITHOUT ARCHITECTS APPROVAL. **ENSURE COMPLIANCE WITH ALL THE NOTES.** 

DO NOT SCALE DRAWING. CONCLUSIONS DERIVED BY SCALING OF DRAWINGS WILL NOT BE ACCEPTED. PLEASE VERIFY INFORMATION WITH THE ARCHITECT OF RECORD.

# **GENERAL NOTES:**

- 01. CONTRACTOR SHALL CHECK AND VERIFY ALL DIMENSIONS AND CONDITIONS ON SITE AND REPORT ANY DISCREPANCIES TO THE ARCHITECT PRIOR TO PROCEEDING WITH LAYOUT AND DESIGN WORK OR DURING BIDDING PROCESS(IF APPLICABLE).
- 02. ALL WORK CALLED FOR ON THESE DRAWINGS SHALL BE IN COMPLIANCE WITH CODES, RULES AND REGULATIONS OF ALL GOVERNMENTAL AGENCIES, HAVING JURISDICTION. THIS INCLUDES BUT IS NOT LIMITED TO THE ONTARIO BUILDING CODE, THE ONTARIO ELECTRICAL SAFETY CODE, FIRE PROTECTION CODES AND THE ACCESSIBILITY GUIDELINES.
- 02. ALL FLOORS TO BE LEVEL THROUGHOUT AND HAVE SMOOTH
- 03. THE CONTRACTOR MUST COMPLY WITH ANY AND ALL RULES SET BY EITHER THE BUILDING OWNER AND OR BUILDINGS MANAGEMENT
- 04. THE CONTRACTOR IS TO REMOVE ALL DEBRIS ASSOCIATED WITH THE DEMOLITION / THE CONSTRUCTION OF THE PROJECT. THE CONSTRUCTION SITE IS TO BE BROOM SWEPT AT THE CONCLUSION OF EACH WORKING DAY
- 05. THE CONTRACTOR IS TO SUPPLY ALL MATERIAL AND LABOR NECESSARY TO COMPLETE THE WORK DESCRIBED HEREIN.
- 06. CONTRACTOR TO CO-ORDINATE WITH MECH. AND ELECT CONTRACTORS FOR LOCATION AND SIZES OF ALL WALLS, FLOORS & CEILING OPENINGS, EQUIPMENT ETC.
- 07. THE CONTRACTOR IS RESPONSIBLE FOR SECURING THE CONSTRUCTION SITE AND FOR THE STORAGE MATERIALS.
- 08. THE CONTRACTOR SHALL LOCATE AND VERIFY ALL EXISTING SERVICES (EXPOSED AND CONCEALED) PRIOR TO ANY DEMOLITION, CUTTING DRILLING OR DIGGING. SERVICES CUT OR DAMAGED AND ANY RESULTING DAMAGE TO PREMISES CAUSED FROM FAILURE TO DO SO WILL BE THE RESPONSIBILITY OF THE CONTRACTOR.
- 09. THE CONTRACTOR WILL SCHEDULE THE USE AND OR SHUT DOWN OF BUILDING SERVICE WITH THE BUILDING OWNER AND OR MANAGEMENT. CONTRACTOR SHOULD BE PREPARED TO PERFORM ANY WORK RELATED TO THE SAME DURING NON BUSINESS HOURS.

- 10. THE CONTRACTOR SHALL SCHEDULE AND OBTAIN PERMISSION FROM THE BUILDING OWNER AND OR MANAGEMENT FOR ACCESS TO SPACES OUTSIDE OF THE CONSTRUCTION SITE. THESE SPACES INCLUDE, BUT ARE NOT LIMITED TO, MECHANICAL ROOMS, ROODS, ELECTRICAL ROOMS, ADJACENT TENANTS, AND FLOOR ABOVE AND BELOW THE CONSTRUCTION. CONTRACTORS SHOULD BE PREPARED TO PERFORM ANY WORK RELATED TO THE SAME DURING NON **BUSINESS HOURS.**
- 11. THE CONTRACTOR IS RESPONSIBLE FOR PROTECTING ALL COMPLETED WORK AND AREAS WITHIN THE BUILDING USED FOR ACCESS TO THE CONSTRUCTION SITE. THIS INCLUDES, BUT IS NOT LIMITED TO, PUBLIC CORRIDORS, ELEVATORS, LOBBIES, LOADING DOCKS AND TOILET FACILITIES. CONTRACTOR IS ALSO TO CLEAN THE SAME AFTER USE.
- 12. WHEN SUBMITTALS ARE CALLED FOR ON THE DOCUMENTS, THEY ARE FIRST TO BE REVIEWED BY THE GENERAL CONTRACTOR, THE SUBMITTAL MUST BE STAMPED INDICATING THE DATE WHEN RECEIVED BY THE GENERAL CONTRACTOR, AFTER THE GENERAL CONTRACTORS REVIEW, SUBMITTALS CAN THEN BE ISSUED TO THE ARCHITECT AND OR ENGINEER. AL SUBMITALLS ARE TO BE SUPPLIED TO THE ARCHITECT IN TRIPLICATE.
- 13. ANY EXISTING SPRAYED FIREPROOFING DAMAGED OR REMOVED IS TO BE REPAIRED AND ITS REPAIR APPROVED BY THE ARCHITECT
- 14. THE CONTRACTOR IS TO WARRANTY ALL WORK, MATERIALS AND EQUIPMENT FOR A PERIOD OF TIME AS PER AGREED WITH CLIENT BEFORE STARTING THE WORK AND HIS WARRANTY TIME STARTS AT THE DATE OF SUBSTANTIAL COMPLETION.
- 15. THE CONTRACTOR IS RESPONSIBLE FOR FINAL FINE CLEANING AT THE COMPLETION OF THE JOB PRIOR TO OCCUPANCY.
- 16. STUD WALL DESIGN SHOULD ACCOMMODATE ANY EXPECTED DEFLECTION OF THE EXISTING FLOOR STRUCTURE AS REQUIRED.
- 17. CONTRACTOR SHALL BE RESPONSIBLE FOR REPLACING DAMAGED SPRAY-ON FIREPROOFING FROM DISTURBED STRUCTURAL STEEL (IF APPLICABLE).
- 18. ALL DOOR HARDWARE MUST HAVE A SHAPE THAT IS EASY TO GRASP WITH ONE HAND AND DOES NOT REQUIRE TIGHT GRASPING, TIGHT PINCHING, OR TWISTING OF THE WRIST TO OPERATE.
- 19. THE CONTRACTOR MUST COMPLY WITH ANY AND ALL RULES SET BY EITHER THE BUILDING OWNER AND OR BUILDINGS MANAGEMENT.
- 20. EXACT LOCATION OF ALL MECHANICAL, ELECTRICAL, PLUMBING AND DRAINAGE, H.V.A.C. AND FIRE PROTECTION COMPONENTS TO BE DETERMINED ON SITE
- 21. GENERAL CONTRACTOR TO CO-ORDINATE WITH MECH. AND ELECT. CONTRACTORS FOR LOCATION AND SIZES OF ALL WALLS, FLOORS & CEILING OPENINGS, EQUIPMENT ETC. AS WELL AS RECESSES AND CHASES IN WALLS AND FLOORS. OPENINGS REQ. TO THE BUILDING ENVELOP TO BE DONE BY LANDLORD AT THE TENANTS COST.

- 22. ALL ELECTRICAL WORK SHALL BE PERFORMED BY SKILLED LICENSED ELECTRICIANS IN ACCORDANCE WITH THE BEST PRACTICES OF THE TRADE, MEETING THE REQUIREMENT OF THE LATEST EDITION OF THE NATIONAL ELECTRICAL CODE, APPLICABLE FEDERAL PROVINCIAL & LOCAL CODES.
- 23. ALL GYPSUM BOARD SURFACES TO BE TAPED, PLASTERED, SANDED AND FINISHED READY TO RECEIVE PAINT / FINISHES AS INDICATED ON DRAWINGS. FOR PAINT SELECTION COORDINATE WITH CLIENT OR OWNER REP.
- 24. BUILDING SERVICE CONTROLS I.E SWITCHES, THERMOSTATS, ETC, SHALL BE MOUNTED BETWEEN 900MM AND 1200MM ABOVE FINISH FLOOR. REF# 3.8.1.5.(1). OF DIV B.
- 25. BUILDING SERVICES PENETRATING ALL FIRE SEPARATION SHALL BE COMPLETED WITH FIRE STOPPING MEASURES IN CONFORMANCE WITH 'DIVISION B' SUB SECTION 3.1.9. OF THE ONTARIO BUILDING CODE 2012. MAINTAIN ALL EXISTING FIRE SEPARATION C/W REQUIRED FIRE RESISTANCE RATING.
- 26. ALL INTERIOR FINISHES TO HAVE A MAXIMUM 150 FLAME SPREAD RATING AS PER 3.1.13.2 OF DIVISION B. FLOOR FINISHES SHALL BE TIGHT, SMOOTH AND NON **ABSORBENT**
- 27. FOR FINISHES SPECIFICATIONS, COORDINATE WITH TENANT ALL DOORS AND FRAMES TO BE PAINTED
- 28. ALL EXISTING SURFACES TO REMAIN ARE TO BE PROTECTED THROUGHOUT DEMOLITION AND CONSTRUCTION
- 29. PORTABLE FIRE EXTINGUISHER PER NFPA-10 INSTALLED BY GC ON SITE AND SUBJECT TO LOCAL JURISDICTION APPROVAL. 10LBS IN KITCHEN, 5LBS ELSEWHERE.

# DOOR & HARDWARE NOTES:

- 01. ALL DOOR HARDWARE MUST HAVE A SHAPE THAT IS EASY TO GRASP WITH ONE HAND AND DOES NOT REQUIRE TIGHT GRASPING, TIGHT PINCHING, OR TWISTING OF THE WRIST TO OPERATE.
- 02. ENSURE PANIC HARDWARE IS INSTALLED ON ALL EGRESS DOORS. G.C TO FURNISH AND INCLUDE PRICE ON BID.
- 03. SEAL BOTTOM OF WOOD DOORS.

# **WALL NOTES:**

- 01. PROVIDE 1/2" PLYWOOD FROM FLOOR TO 4'-0" AFF AT INTERIOR TOILET ROOM WALLS.
- 02. ALL INTERIOR WALLS TO BE FRAMED TO UNDERSIDE OF CEILING JOISTS ABOVE AS NEEDED TO ACCOMMODATE CEILING
- 03. PROVIDE & INSTALL BLOCKING FOR ALL WASHROOM ACCESSORIES, HANDRAIL, CABINETS, ETC. 04. WALLS TO RECEIVE TILE BASE SHALL HAVE 1/2" CGC
- "DUROCK" INSTALLED TO 18" AFF. 05. ALL CORNERS IN KITCHEN MUST BE WRAPPED AROUND WITH STAINLESS STEEL COVERS. SEE DETAIL

# **ACCESSIBILITY NOTES:**

- 01. EMERGENCY WARNING SYSTEMS SHALL INCLUDE BOTH AUDIBLE AND VISUAL ALARMS. THE VISUAL ALARMS SHALL BE LOCATED THROUGHOUT, INCLUDING RESTROOMS, AND PLACED 80" ABOVE THE FLOOR OR 6" BELOW CEILING, WHICHEVER IS LOWER WHERE APPLICABLE.
- 02. DOORS TO ALL ACCESSIBLE SPACES SHALL HAVE ACCESSIBLE HARDWARE (i.e. LEVER-OPERATED, PUSH-TYPE, U-SHAPED) MOUNTED NO HIGHER THAN 48" ABOVE THE FLOOR.
- 03. FLOOR SURFACES SHALL BE STABLE, FIRM, AND SLIP-RESISTANT. CHANGES IN LEVEL BETWEEN 0.25" AND 0.5" SHALL BE BEVELED WITH A SLOPE NO GREATER THAN 1:2. CHANGES IN LEVEL GREATER THAN 0.5" REQUIRE RAMPS. CARPET PILE THICKNESS SHALL BE 0.5" MAX. GRATINGS IN FLOOR SHALL HAVE SPACES NO GREATER THAN 0.5" WIDE IN ONE DIRECTION. DOORWAY THRESHOLDS SHALL NOT EXCEED 0.5" IN HEIGHT.
- 04. HOT WATER AND DRAIN PIPES UNDER ACCESSIBLE LAVATORIES AND SINKS SHALL BE INSULATED OR OTHERWISE CONFIGURED TO PROTECT AGAINST CONTACT. THERE SHALL BE NO SHARP OR ABRASIVE SURFACES UNDER LAVATORY OR SINK
- 05. STAIRCASES, HANDRAILS, GUARDS AND EXIT DEVICES TO COMPLY WITH ONTARIO BUILDING CODE SECTION 1.3.3.1(e) FOR OCCUPANCY REQUIREMENT AND 3.4.6. G.C TO VERIFY ON SITE.

# **ELECTRICAL NOTES:**

- 01. THE FOLLOWING MATERIAL AND EQUIPMENT WILL BE FURNISHED AND/OR INSTALLED BY OTHERS: LOW VOLTAGE (24 VOLT) WIRE AND CABLE, COMMUNICATION DEVICES, SECURITY EQUIPMENT, POINT OF SALE (POS) EQUIPMENT, SIGNAGE ETC.
- 02.GENERAL REQUIREMENTS: ALL WORK SHALL BE PERFORMED BY SKILLED LICENSED ELECTRICIANS IN ACCORDANCE WITH THE BEST PRACTICES OF THE TRADE. MEETING THE REQUIREMENTS OF THE LATEST EDITION OF THE NATIONAL ELECTRICAL CODE, APPLICABLE FEDERAL, PROVINCIAL AND LOCAL CODES, ELECTRICAL SAFETY AUTHORITY AND THE REQUIREMENTS OF THE ELECTRICAL UTILITY COMPANY FURNISHING THE SERVICES. ALL NECESSARY CONSTRUCTION PERMITS AND CERTIFICATES OF INSPECTION SHALL BE PURCHASED AND OBTAINED UNDER THIS CONTRACT.
- 03.COORDINATION: ALL OUTLETS MUST BE ACCURATELY LOCATED, PARTICULARLY APPLIANCE OUTLETS . REVIEW APPLIANCES CUT-SHEETS AND MANUFACTURER'S SPECIFICATIONS FOR ALL ELECTRICAL REQUIREMENTS.
- 04. SIGNAGE LIGHTING: PROVIDE A 1" RIGID GALVANIZED STEEL ELECTRICAL CONDUIT, AND WIRING, FROM THE PANEL TO ALL ILLUMINATED SIGNS. COORDINATE WITH OWNER THE LOCATION OF SIGNAGE.
- 05.ELECTRICAL WIRING AND CABLES EXPOSED WITHIN THE CEILING SPACE MUST CONFORM TO O.B.C. 3.6.4.3.(1).

NAM	E OF PROJECT:	PROPOSED	MEHFILL RESTAURANT AN		Date:
LOC	ATION:	AT UNIT 50 &	51 - 125 COMMERCE VALLEY		
ITEM	ONTARIO	BUILDING	G CODE DATA MATRIX	(	
	PROJECT DES	CRIPTION:	☐ NEW		☐ PAF
1	UNIT FINI	SH	☐ ADDITION		1.1.1 TO

	PROJECT DES		d.		NEW			RT 11	M P	ART 3	□ PART 9
1			ν.								
'	UNIT FIN				ADDITIO		1.1.1 TO	11.4	1.1.2	(A)	2.1.1
	☐ CHANGE	OF USE			ALTERA	TION					9.10.1.3
2	MAJOR OCCUP		<u>G</u> R	ROUP D					3.1.	2.1.(1)	9.10.2
3	BUILDING AREA	ILDING AREA (m ) <sup>2</sup> (EXISTING TO REMAIN AS IS) NEW 0 TOTAL					1.4.	1.2 (A)	1.1.3.2		
3a	BUILDING CLASSIFICATION 3.2.2.49										
4	GROSS AREA (	m ) <sup>2</sup>	(EX	ISTING TO REMAI	N AS IS)	NEW 0	TOTAL		1.4.	1.2 (A)	1.1.3.2
4a	AREA OF WOR	K	52	297 FT² (492.1 M	l <sup>2</sup> )						
5	NUMBER OF S	TOREYS	ABOV	E GRADE: 8	BELOW	GRADE: 0	MEZZANINE: -		3.2.	1.1 & 1.4.1.2 (A)	2.1.1.3
6	NUMBER OF S	TREET/AC	CESS F	ROUTES 2	2				3.2.2	2.10 & 3.2.5.5	9.10.20
7	UNIT CLASSIFI	CATION	GF	ROUP A2					3.2.2	23	
8	SPRINKLER SY	STEM	⊠ E	XISTING	M El	NTIRE BUILD	ING		3.2.2	2083	9.10.8.2.
			□ P	ROPOSED	□ в	ASEMENT OI	NLY		INDE	X	INDEX
				OT REQUIRED	) [ I	N LIEU OF R	OOF RATING				
9	STANDPIPE				✓ Y	ES	NO		3.2.	9	9.10.17.2
10	FIRE ALARM				MY	ES 🗌	NO		3.2.	4	
11	WATER SERVIC	E/SUPPL	Y IS ADE	EQUATE		ES	NO		3.2.	5.7	N/A
12	HIGH BUILDING	 }				ES	NO		3.2.	6	N/A
13	PERMITTED CC	NSTRUC	ΓΙΟΝ 🗌	COMBUSTIBL	E NO	N-COMBUST	IBLE ⊠ BOT	Н	3.2.2	.2083	9.10.6
	ACTUAL CONS	TRUCTION	v $\square$	COMBUSTIBL		N-COMBUST			3.2.2	62	
14						1 CONIDCO	BLL V BOT		3.2.1	.1.(3)-(8)	9.10.4.1
	MEZZANINE(S) AREA (M ) <sup>2</sup> OCCUPANT LOAD BASED ON ☐ m <sup>2</sup> / PERSON ☑ DESIGN OF SUITE					. , . ,					
15	OCCUPANT LO	AD BASE	O ON	$\prod$ m <sup>2</sup> / PEF	RSON 🖾	DESIGN OF	SUITE		3.1.1	7 (6)	9.9.1.3
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	UNIT		O ON		LC	)AD : 100 PE	ERSONS			7 (6)	
15			O ON	☐ m <sup>2</sup> / PEF	LC		ERSONS		3.8		9.9.1.3 9.5.2 9.10.1.3
16	UNIT	DESIGN		₩ YE	s 🗆	NO (EXPLAII	ERSONS		3.8 3.3.1.2	2.(1)&3.3.1.19(1)	9.5.2 9.10.1.3 9.10.9
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16 17	UNIT BARRIER-FREE	DESIGN  BUBSTANC  ROOF N  FLOORS	CES HORIZO F IA HOUF S 3/4 HO	YES  NTAL ASSEMS FRR (HOURS)	s 🗆	NO (EXPLAII  NO  LISTE OR DESC EXISTING	ERSONS  N)  ED DESIGN No.  CRIPTION (SB-2  G TO REMAIN		3.8 3.3.1.2	2.(1)&3.3.1.19(1)	9.5.2 9.10.1.3 9.10.9
16 17	UNIT BARRIER-FREE	EDESIGN EUBSTANC ROOF N FLOORS MEZZAN	CES HORIZO F IA HOUF 3/4 HO	YES  ONTAL ASSEM FRR (HOURS) RS OURS HOURS	S M BLIES	NO (EXPLAII  NO  LISTE OR DESC EXISTING LIST	ERSONS  N)  ED DESIGN No. CRIPTION (SB-2		3.8 3.3.1.2	2.(1)&3.3.1.19(1)	9.5.2 9.10.1.3 9.10.9
16 17	UNIT BARRIER-FREE	EDESIGN EUBSTANC ROOF N FLOORS MEZZAN	CES HORIZO F IA HOUF 3/4 HO NINE NA	YES  NTAL ASSEM FRR (HOURS) RS DURS HOURS	S M BLIES	NO (EXPLAII  NO  LISTE OR DESC EXISTING LIST OR DES	ERSONS  N)  ED DESIGN No. CRIPTION (SB-2 G TO REMAIN		3.8 3.3.1.2	2.(1)&3.3.1.19(1)	9.5.2 9.10.1.3 9.10.9
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16 17 18	UNIT  BARRIER-FREE  HAZARDOUS S	ROOF N FLOORS ROOF 0 MEZZAN	CES HORIZO FIA HOUF 3/4 HO NINE NA OF SUP NA HO HOURS	YES  ONTAL ASSEM FRR (HOURS) RS OURS HOURS PORTING ME OURS HOURS	S  BLIES  MBERS	NO (EXPLAII  NO LISTE OR DESC EXISTING LIST OR DESC EXISTING	ERSONS  N)  ED DESIGN No. CRIPTION (SB-2 G TO REMAIN  TED DESIGN No. SCRIPTION (SB-	. 2)	3.8 3.3.1.2 3.2.2.2	2.(1)&3.3.1.19(1) 2083& 3.2.1.4	9.5.2 9.10.1.3 9.10.9 9.10.8
16 17	BARRIER-FREE HAZARDOUS S SPATIAL SEPAI	ROOF N FLOORS ROOF 0 MEZZAN RATION-C	OF SUP S NA HOURS NINE 0 HOURS	YES  NTAL ASSEM FRR (HOURS) RS DURS HOURS HOURS HOURS HOURS UCTION OF E	S S BLIES  MBERS	NO (EXPLAIL NO LISTE OR DESCENSTING	ERSONS  ED DESIGN No. CRIPTION (SB-2 G TO REMAIN  ED DESIGN No. SCRIPTION (SB-	. 2)	3.8 3.3.1.2 3.2.2.2	2.(1)&3.3.1.19(1) 2083& 3.2.1.4 D	9.5.2 9.10.1.3 9.10.9 9.10.8
16 17 18	BARRIER-FREE HAZARDOUS S SPATIAL SEPAI WALL AREA OF	FRR FLOORS ROOF 0 MEZZAN RATION-C	DES HORIZO FIA HOUF S 3/4 HO NINE NA HOURS NINE 0 H ONSTRI	YES  NTAL ASSEM FRR (HOURS) RS DURS HOURS	S S BLIES  MBERS  XTERIOR S PROPOSE	NO (EXPLAIL NO LISTE OR DESCENSTING	ERSONS  ED DESIGN No. CRIPTION (SB-2 G TO REMAIN  ED DESIGN No SCRIPTION (SB-		3.8 3.3.1.2 3.2.2.2 3.2.3.1.1	2.(1)&3.3.1.19(1) 2083& 3.2.1.4 D COMB. CONSTR.	9.5.2 9.10.1.3 9.10.9 9.10.8
16 17 18	BARRIER-FREE HAZARDOUS S SPATIAL SEPAI WALL AREA OF EBF	ROOF N FLOORS ROOF 0 MEZZAN RATION-C	OF SUPONSTRI	YES  ONTAL ASSEM FRR (HOURS) RS OURS HOURS HOURS UCTION OF E PERMITTED MAX % OF	S S BLIES  MBERS  XTERIOR Y PROPOSE % OF	NO (EXPLAII  NO LISTE OR DESCENSION LIST OR DESCENSION WALLS ED FRR (HOURS)	ERSONS  ED DESIGN No. CRIPTION (SB-2 G TO REMAIN  ED DESIGN No SCRIPTION (SB- G TO REMAIN  LISTED  DESIGN OR	. 2)	3.8 3.3.1.2 3.2.2.2 3.2.3.1.1	2.(1)&3.3.1.19(1) 2083& 3.2.1.4 D COMB. CONSTR. NONC.	9.5.2 9.10.1.3 9.10.9 9.10.8
16 17 18	BARRIER-FREE HAZARDOUS S  SPATIAL SEPAI WALL AREA OF EBF (m) <sup>2</sup>	FRR FLOORS ROOF 0 MEZZAN RATION-C	DES HORIZO FIA HOUF S 3/4 HO NINE NA HOURS NINE 0 H ONSTRI	YES  NTAL ASSEM FRR (HOURS) RS DURS HOURS	S S BLIES  MBERS  XTERIOR Y PROPOSE % OF	NO (EXPLAII  NO LISTE OR DESCENSION LIST OR DESCENSION WALLS ED FRR (HOURS)	ERSONS  ED DESIGN No. CRIPTION (SB-2 G TO REMAIN  ED DESIGN No SCRIPTION (SB-		3.8 3.3.1.2 3.2.2.2 3.2.3.1.1	2.(1)&3.3.1.19(1) 2083& 3.2.1.4 D COMB. CONSTR.	9.5.2 9.10.1.3 9.10.9 9.10.8
16 17 18	SPATIAL SEPAI WALL AREA OF EBF (m) <sup>2</sup> NORTH	FRR FLOORS ROOF 0 MEZZAN RATION-C	OF SUPONSTRI	YES  ONTAL ASSEM FRR (HOURS) RS OURS HOURS HOURS UCTION OF E PERMITTED MAX % OF	S S BLIES  MBERS  XTERIOR Y PROPOSE % OF	NO (EXPLAII  NO LISTE OR DESCENSION LIST OR DESCENSION WALLS ED FRR (HOURS)	ERSONS  ED DESIGN No. CRIPTION (SB-2 G TO REMAIN  ED DESIGN No SCRIPTION (SB- G TO REMAIN  LISTED  DESIGN OR		3.8 3.3.1.2 3.2.2.2 3.2.3.1.1	2.(1)&3.3.1.19(1) 2083& 3.2.1.4 D COMB. CONSTR. NONC.	9.5.2 9.10.1.3 9.10.9 9.10.8
16 17 18	BARRIER-FREE HAZARDOUS S  SPATIAL SEPAI WALL AREA OF EBF (m) <sup>2</sup>	FRR FLOORS ROOF 0 MEZZAN RATION-C	OF SUPONSTRI	YES  ONTAL ASSEM FRR (HOURS) RS OURS HOURS HOURS CONTING ME OURS CONTING ME OU	S S BLIES  MBERS  XTERIOR Y PROPOSE % OF OPENING	NO (EXPLAII  NO LISTE OR DESCENSION LIST OR DESCENSION WALLS ED FRR (HOURS)	ERSONS  ED DESIGN No. CRIPTION (SB-2 G TO REMAIN  ED DESIGN NO SCRIPTION (SB- G TO REMAIN  LISTED  DESIGN OR  DESCRIPTION		3.8 3.3.1.2 3.2.2.2 3.2.3.1.1	2.(1)&3.3.1.19(1) 2083& 3.2.1.4 D COMB. CONSTR. NONC.	9.5.2 9.10.1.3 9.10.9 9.10.8

WES							
20 PLU	IMBING FIXTURE REQUIREMENTS						
					OBC	REFERENCE	
		OCCUPANT LOAD	BC TABLE NUMBER	FIXTURES REQUIRED	FIXTURES PROVIDED	PART 3	PART 9
	NT LOAD FOR CALCULATION FOR THE # OF DOMS REQUIREMENTS:	100 PERSONS					
MALE / F	EMALE @ 50% / 50%	50 MALE	3.7.4.3	1	THERE ARE EXISTII THE BUILDING. SEF FEMALES.		
		50 FEMALE	3.7.4.3	1			

DATE

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STRUCTURE CONSULTANT:


MEP CONSULTANT:


PROJ

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PROJECT NAME AND ADDRESS :				DRAWN BY	CHECKED BY	APPRO'	VED BY
PROPOSED MEHFILL RESTAURANT AND BAR				SM	GS	НВ	
AT UNIT 50 & 51- 125 COMMERCE VALLEY DRIVE WEST, MARKHAM, ON				SCALE:	SIZE	ISSUED	DATE
WARRIAW, ON				N.T.S.	36" X 24"	2023-11	-24
DRAWING TITLE :	00	MINOR VARIANCE	2023-11-24	SHEET NO.	STAGE	PHASE	REV
O.B.C. MATRIX AND GENERAL NOTES	RE\/	ISSUED FOR	DATE	A01	MINOR VARIANCE	00	00

REV ISSUED FOR



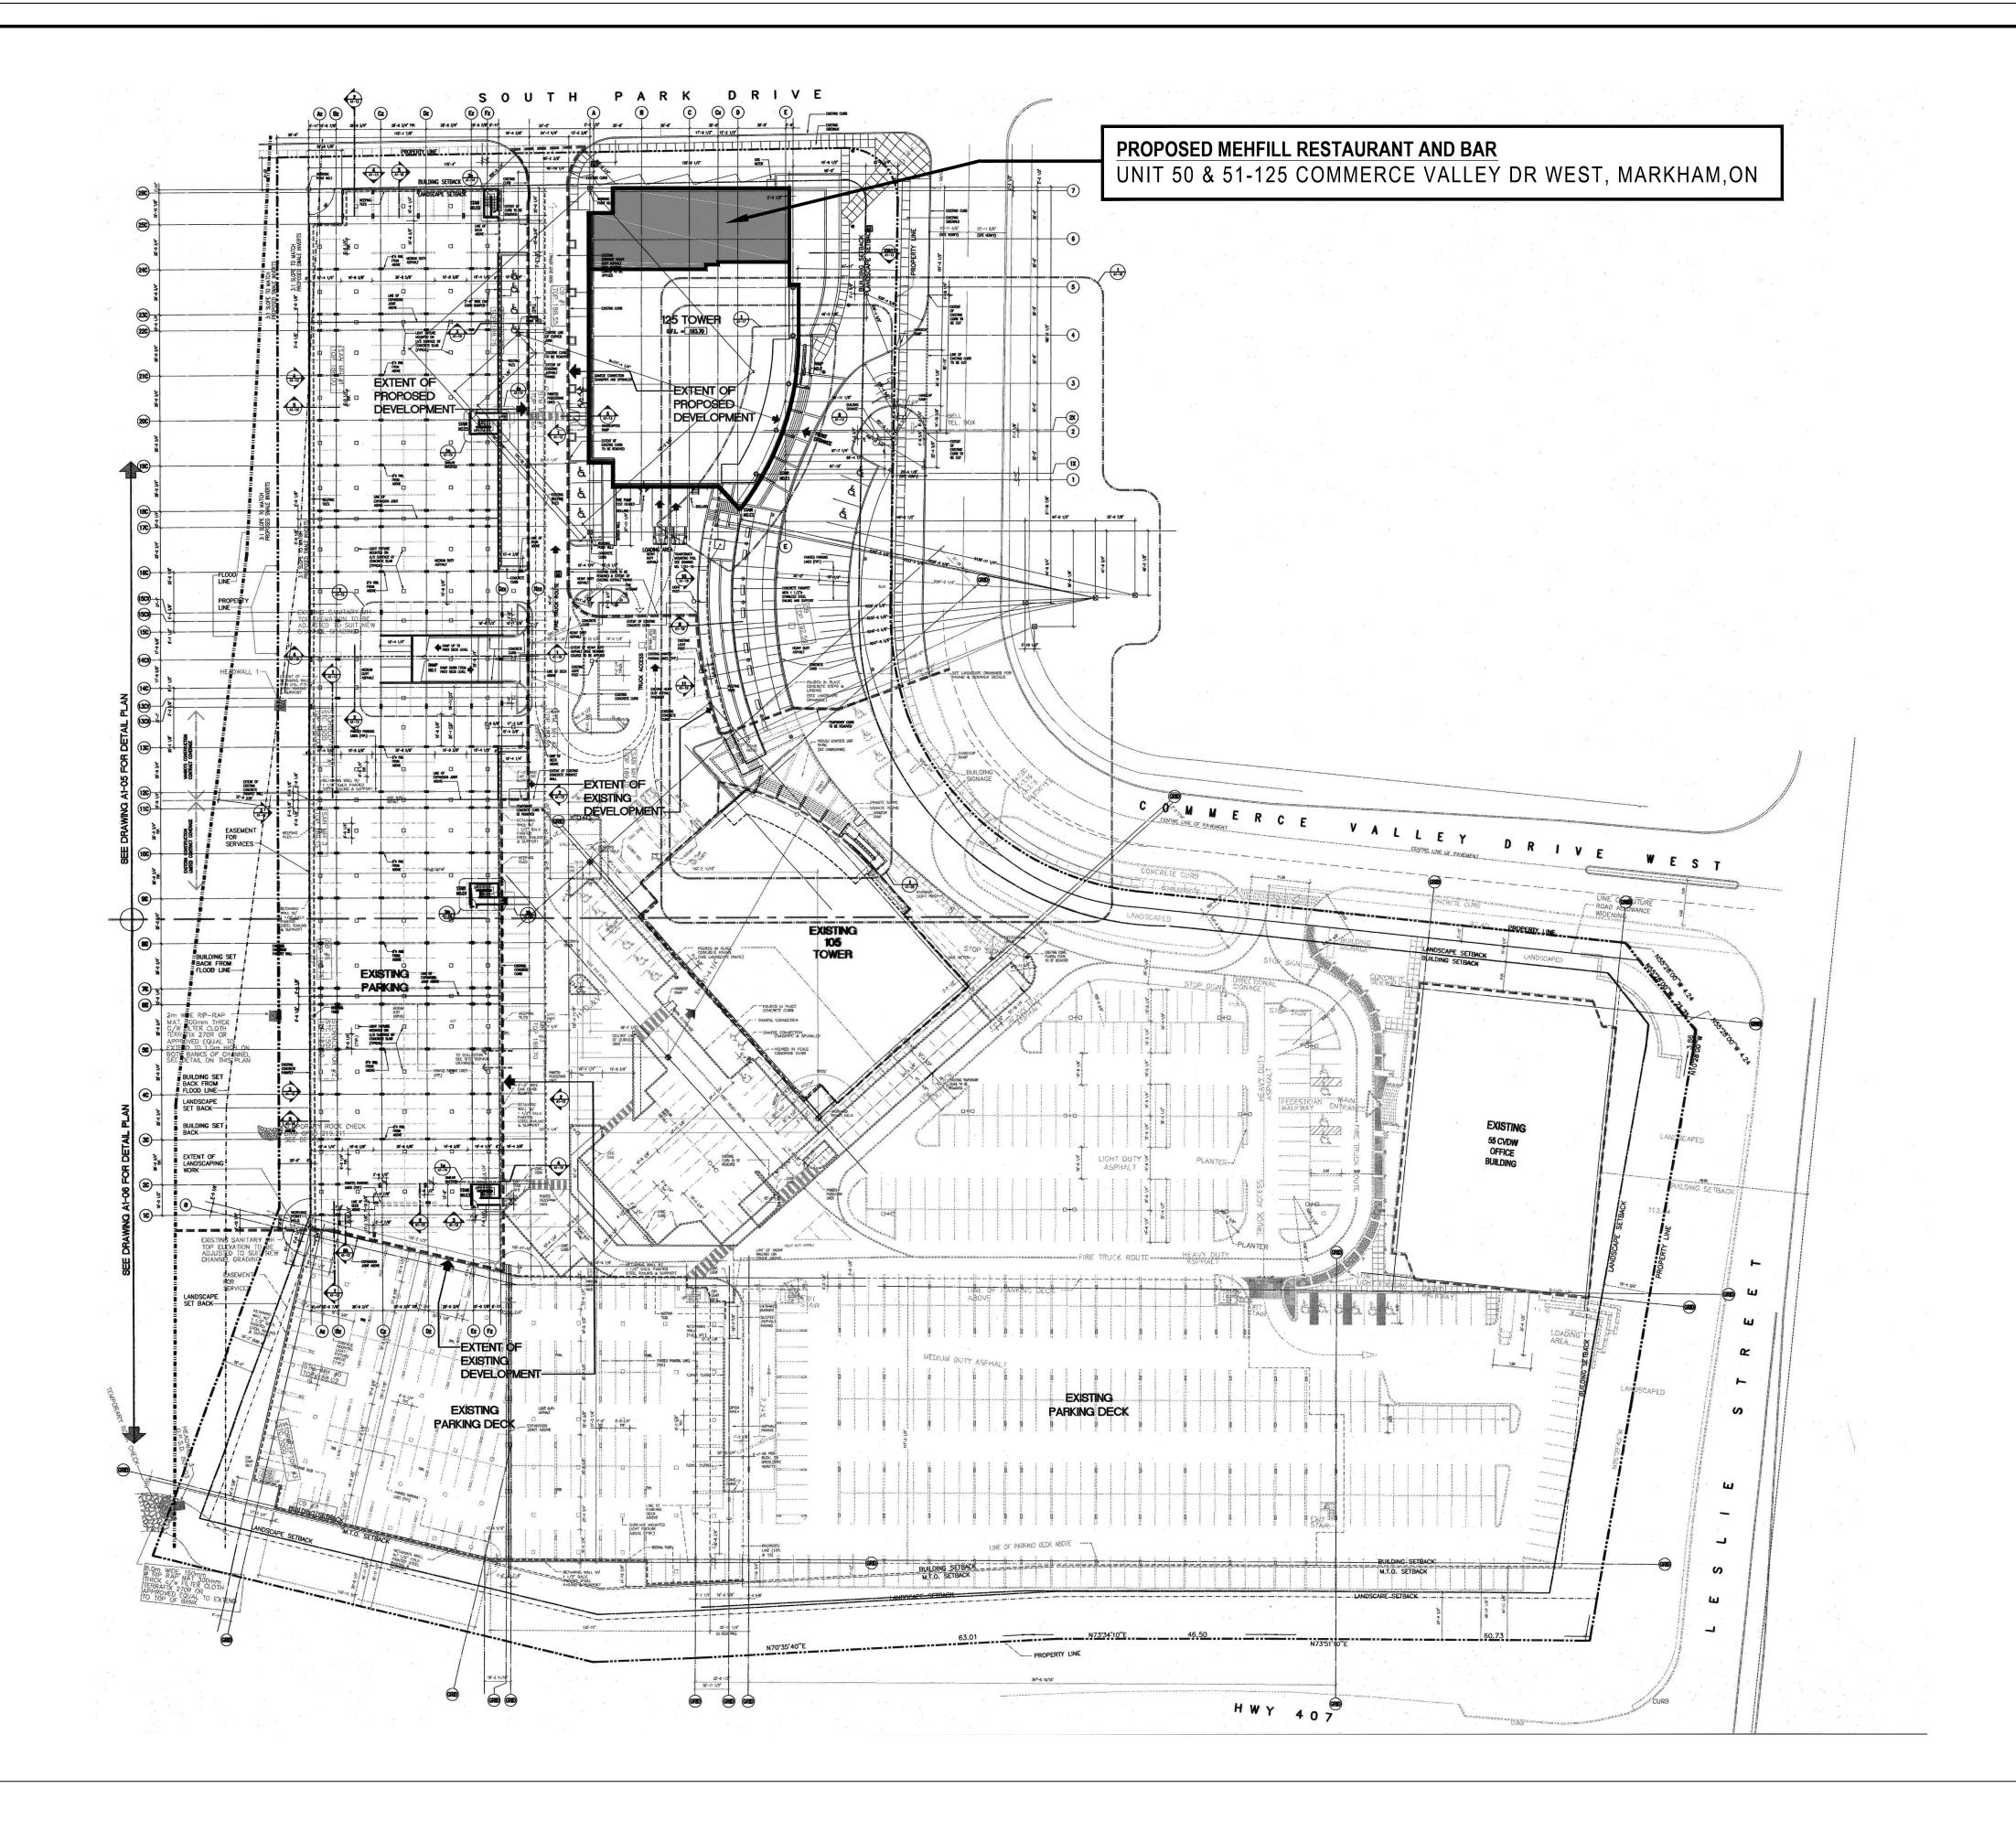
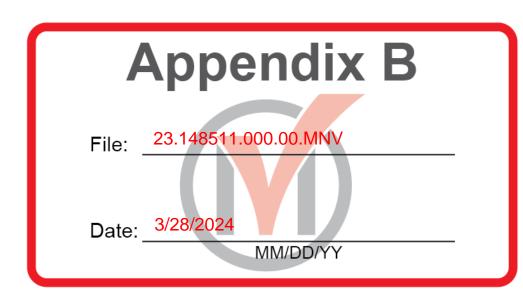
# PARKING FOR NEW PROPOSED RESTAURANT AND BAR

AREA OF THE UNIT- 50 & 51 = 492.10 M<sup>2</sup>

PARKING REQUIRED FOR RESTAURANT AND BAR = 1 PER 9 SQ.M

= 492.10 = 55 PARKING SPACES

AS THESE UNITS WERE CONSIDERED AS OFFICE SPACE WHEN THE BUILDING WAS DESIGNED, THE PARKING SPACES REQUIRED FOR OFFICES WERE ALREADY CONSIDERED FOR UNIT 50 & 51.

1 SPACE PER 30 SQ.M. =  $\frac{492.10}{30}$  = 17 PARKING SPACES

NOW, FOR NEW PROPOSED RESTAURANT AND BAR WE NEED 55 PARKING SPACES, OUT OF WHICH 17 SPACES ARE ALREADY DESIGNATED FOR THE UNIT 50 & 51. NOW WE NEED 55-17=38 PARKING SPACES FOR RESTAURANT AND BAR.

AS PER EXISTING PARKING CALCULATIONS IN THE TABLE BELOW THERE ARE ADDITIONAL 56 PARKING SPACES PROVIDED ON THE SITE AND OUT OF THESE 38 CAN BE USED FOR PROPOSED RESTAURANT AND BAR.

55 CVOW	
SURFACE PARKING DECK LEVEL	449 SF 214 SF
TOTAL	663 SF
105 CVDW	
SURFACE PARKING FIRST DECK SECOND DECK (SMALL 8'-6" WIDTH)	411 SF 151 SF 171 SF
SECOND DECK (SMALL O -O MIDIO)	1/1 3
TOTAL	733 SI
	733 Si 157 Si 229 Si 253 Si
TOTAL  125 CYDN  SURFACE PARKING FIRST DECK	157 Si 229 Si
125 CVDW  SURFACE PARKING FIRST DECK SECOND DECK (SMALL 8'-6" WIDTH)	157 Si 229 Si 253 Si
125 CVDW  SURFACE PARKING FIRST DECK SECOND DECK (SMALL 8'-6" WIDTH)	157 Si 229 Si 253 Si



# THIS DRAWING IS FOR REFERNCE ONLY

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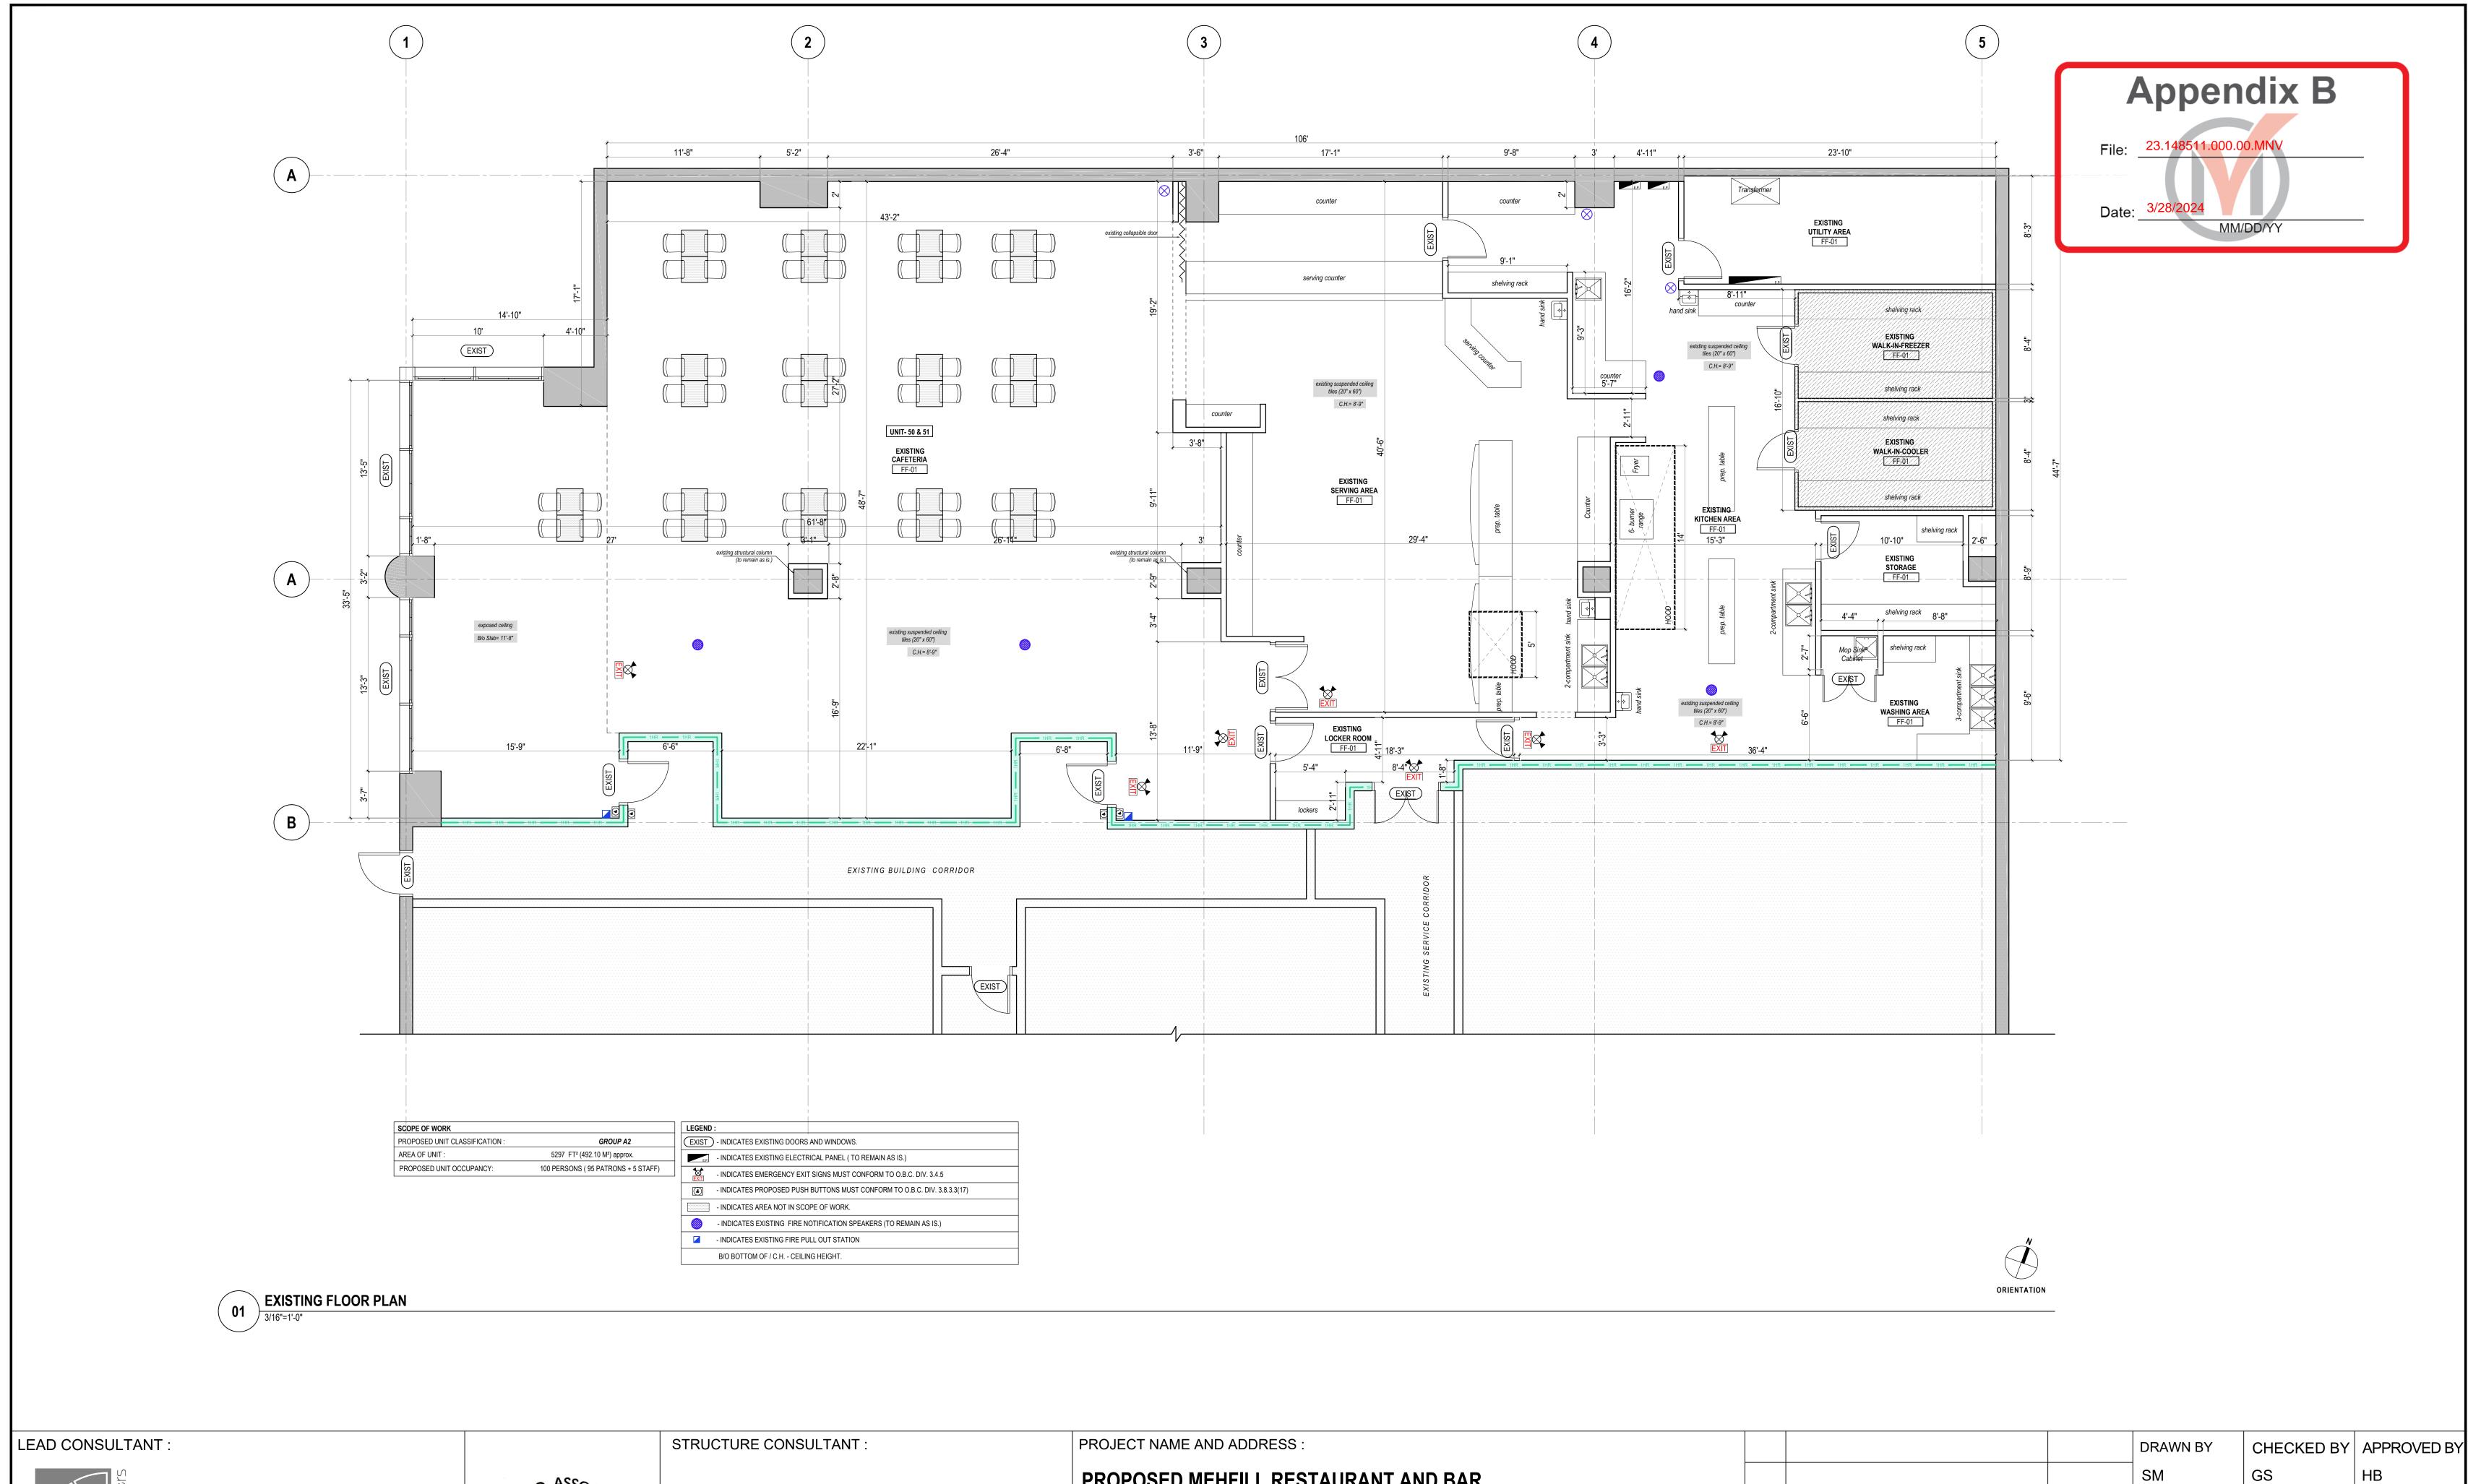
ARCHITECTS Z

HARPREET SINGH BRONS:
LICENCE
6942

	STRUCTURE CONSULTANT :
Clas	
TS Z	MEP CONSULTANT :
BHONS	

PROJECT NAME AND ADDRESS :
PROPOSED MEHFILL RESTAURANT AND BAR
AT UNIT 50 & 51- 125 COMMERCE VALLEY DRIVE WEST,
MARKHAM, ON
DRAWING TITLE :
SITE PLAN

			DRAWN BY	CHECKED BY	APPRO	VED BY
			SM	GS	НВ	
			SCALE:	SIZE	ISSUE	D DATE
			N.T.S.	36" X 24"	2023-11	1-24
0	MINOR VARIANCE	2023-11-24	SHEET NO.	STAGE	PHASE	REV
EV	ISSUED FOR	DATE	A02	MINOR VARIANCE	00	00







MEP CONSULTANT :

PROPOSED MEHFILL RESTAURANT AND BAR AT UNIT 50 & 51- 125 COMMERCE VALLEY DRIVE WEST, MARKHAM, ON				SM SCALE: 3/16"=1'-0"
DRAWING TITLE :	00	MINOR VARIANCE	2023-11-24	SHEET NO.
EXISTING FLOOR PLAN	RFV	ISSUED FOR	DATE	A03

REV ISSUED FOR

ISSUED DATE

2023-11-24

PHASE REV

00

SIZE


STAGE

MINOR

VARIANCE

3/16"=1'-0" | 36" X 24"

DATE

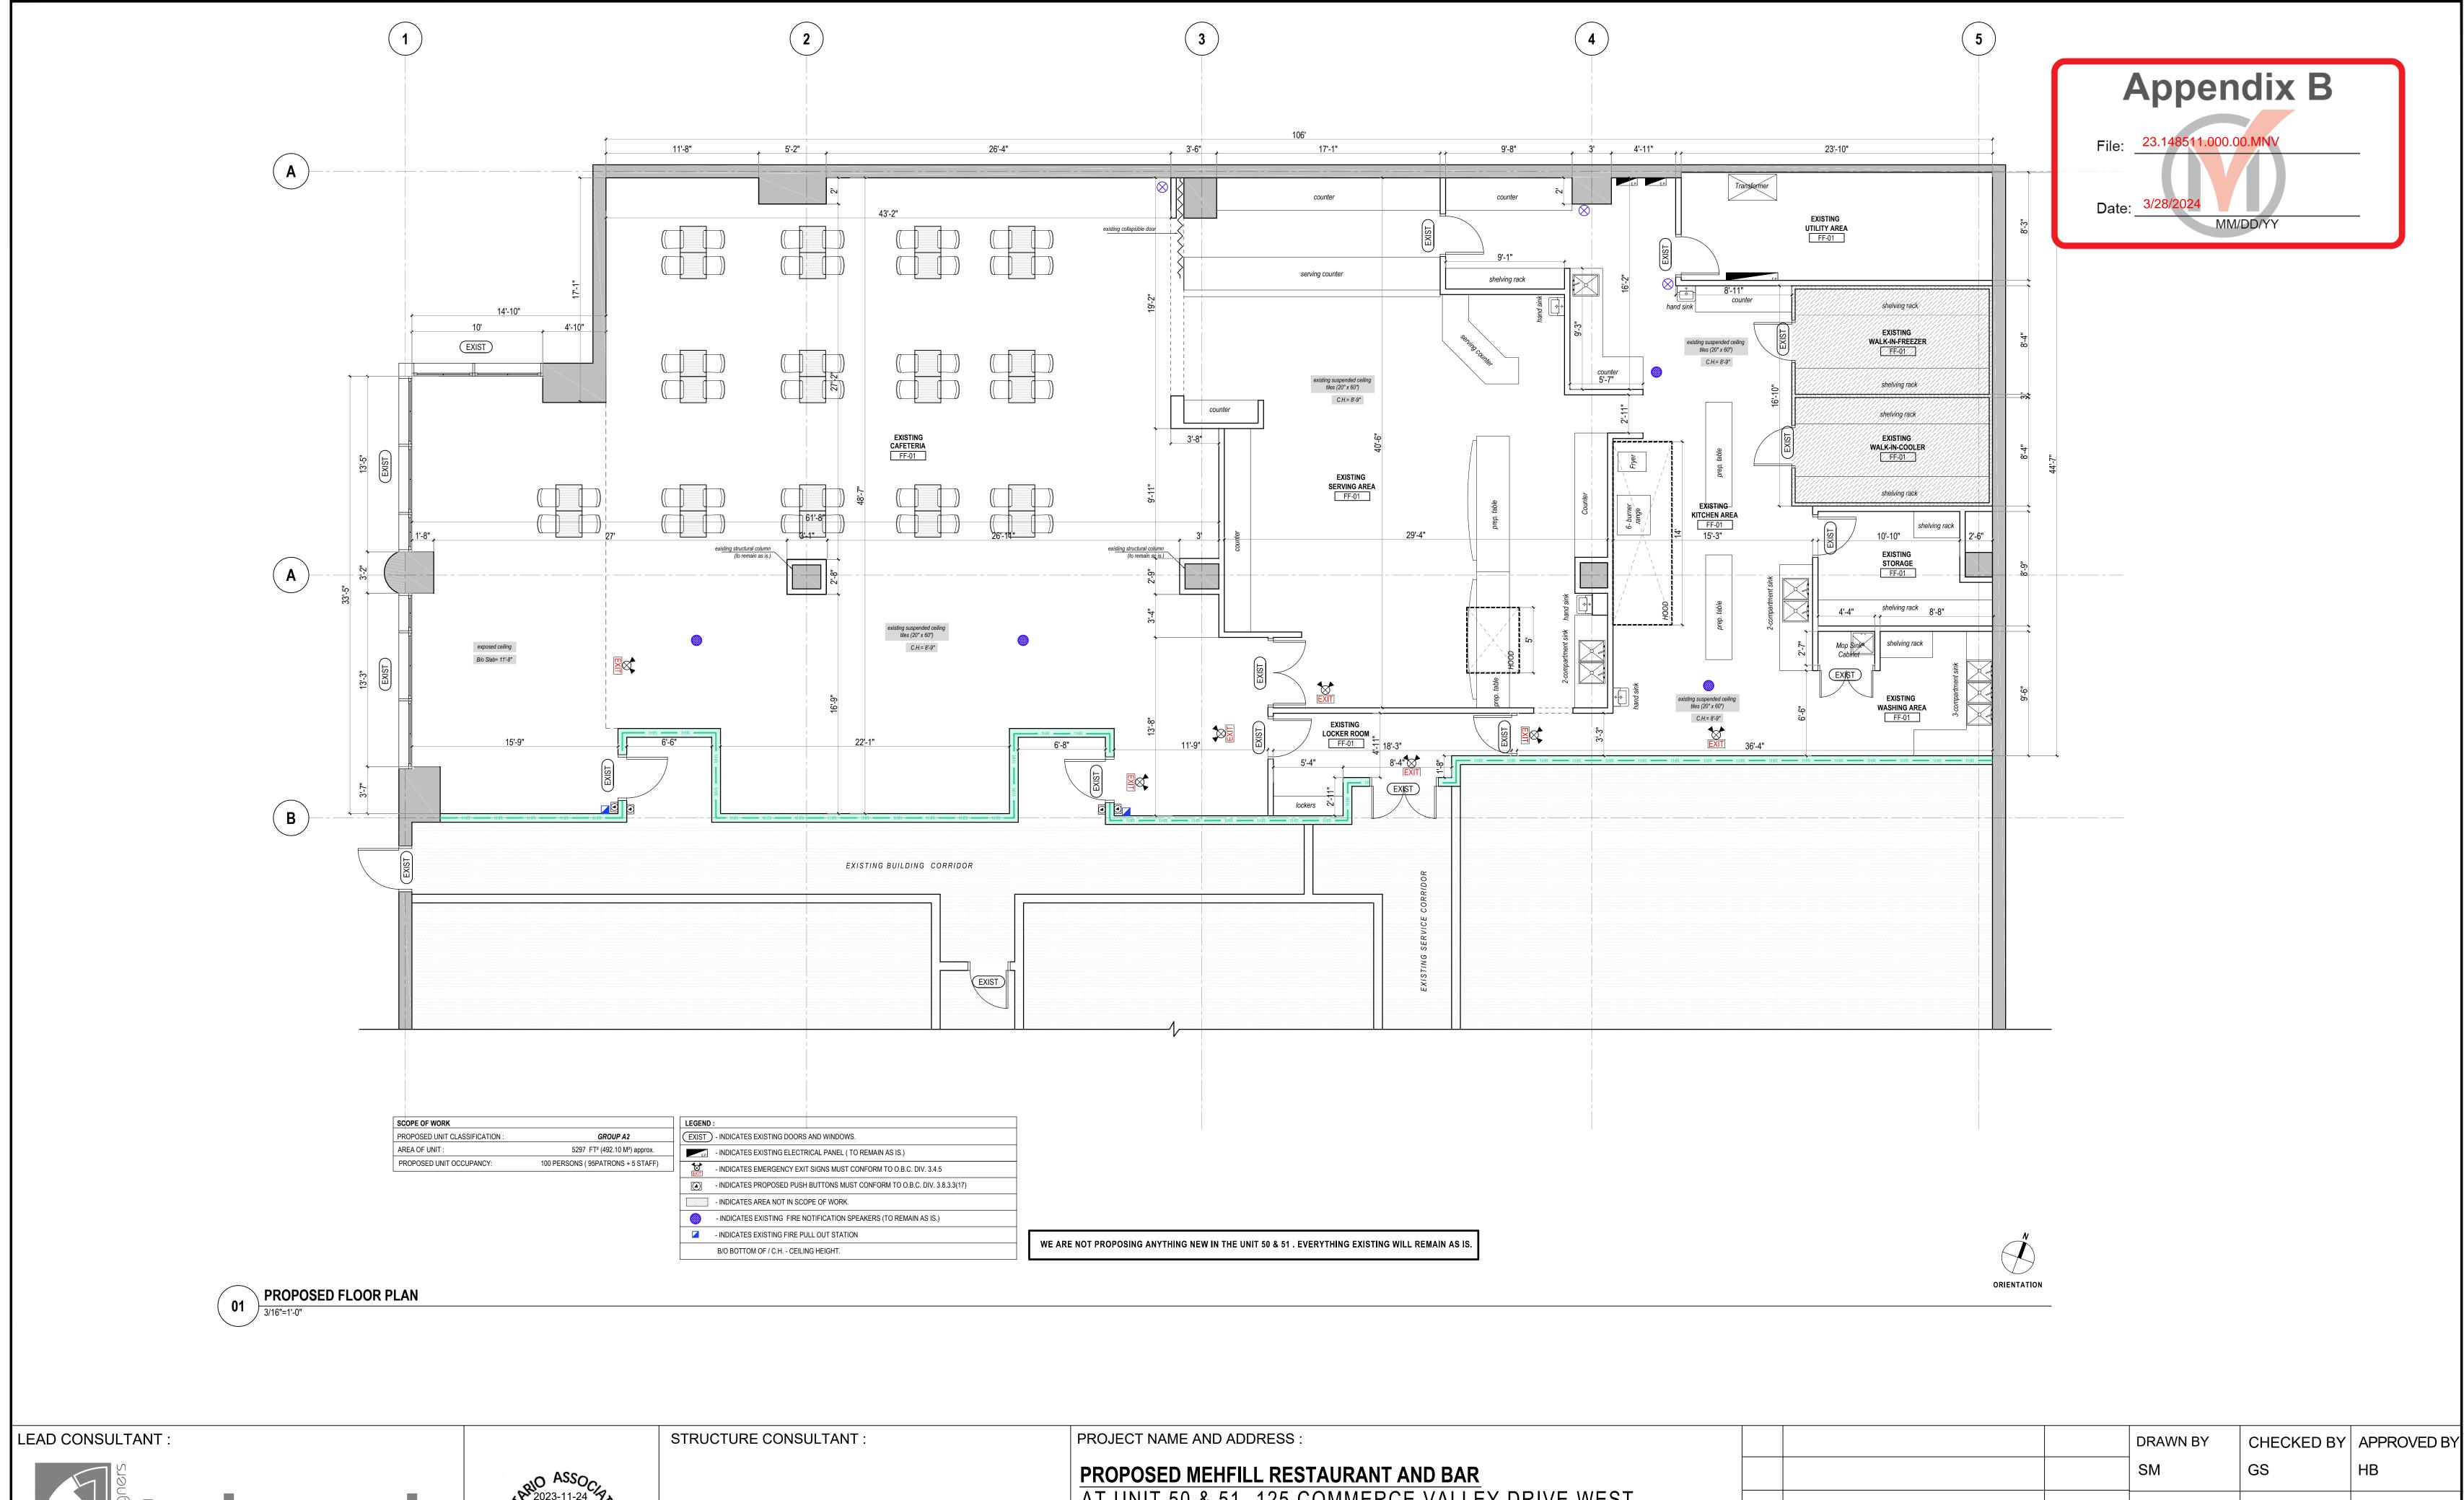

AT UNIT 50 & 51- 125 COMMERCE VALLEY DRIVE WEST, SCALE: SIZE ISSUED DATE MARKHAM, ON MEP CONSULTANT: 36" X 24" 3/16"=1'-0" 2023-11-24 Unit 214 - 2550 Matheson Blvd € Tel: +1-905-792-0038 DRAWING TITLE: 2023-11-24 SHEET NO. STAGE PHASE REV 00 MINOR VARIANCE Mississauga, ON, L4W 4Z1 Cell: +1-416-729-9454 MINOR PROPOSED LAYOUT PLAN Email: hbhons@technoarch.ca www.technoarch.ca 00 VARIANCE REV ISSUED FOR DATE

